


Shingle Venting -

2 Roof Plan Scale: 1/8" = 1'-0"

# ROOF NOTE:

Provide Attic Ventilation as per current IRC requirements through any combination of soffit vents, gable vents, ridge vents, and mechanical ventilation. Roof Penetrations should be located on Sides and Rear of House as to NOT be visible from the Street.

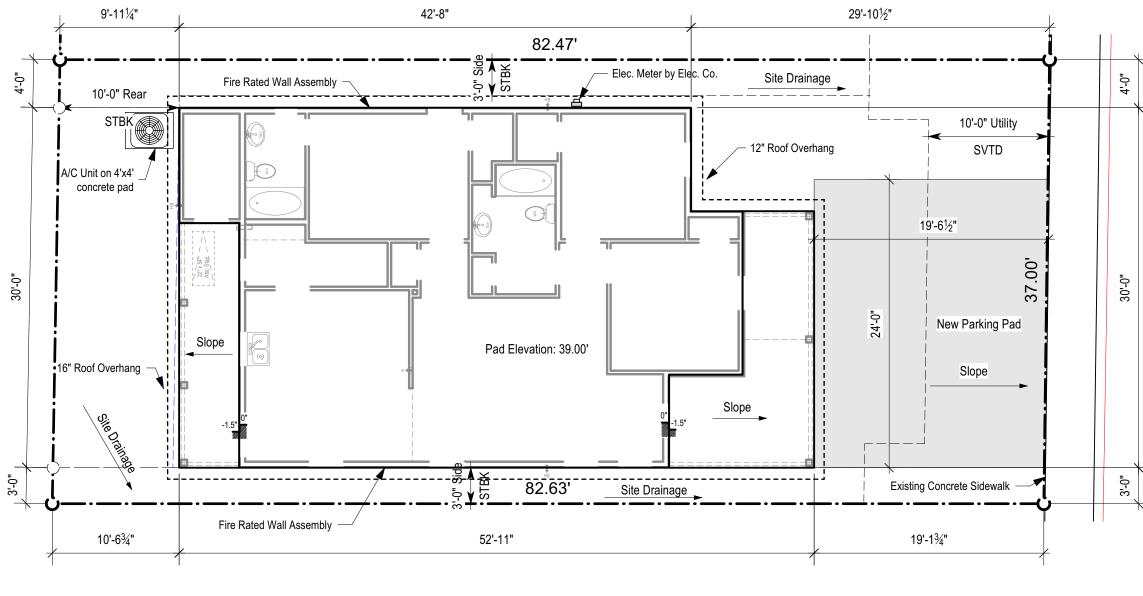



## ABBREVIATIONS

	ABBREVIATIONS
TPAFF	ABOVE FINISHED FLOOR
ABV	ABOVE
ALT	ALTERNATE
@	AT
õc	ON CENTER
CO	CASED OPENING
PLYWD	PLYWOOD
WC	WATER CLOSET (TOILET)
LAV	LAVATORY (SINK)
DBL	DOUBLE
SHWR	SHOWER
TRTD	PRESSURE TREATED WOOD WOOD
WD CONC	CONCRETE
PSI	POUNDS PER SQUARE INCH
COND	AIR-CONDITIONING CONDENSER
SHLF	SHELF
SHLVS	SHELVES
W	WASHING MACHINE
D	CLOTHES DRYER
CLG	CEILING
CJ	CONTROL/ CONSTRUCTION JOINT
EJ	EXPANSION JOINT
GYP BRD	
CONT	CONTINUOUS
REBAR	REINFORCING BAR
CFM	COMPACT FLUORESCENT LAMPS GROUND FAULT INTERRUPTER
GFI PTD	PAINTED
WR	WATER-RESISTANT
OSB	ORIENTED STRAND BOARD
GALV	GALVANIZED
TP	TOILET PAPER

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r				
SYMBOL LEGEND				
SYMBOL	DESCRIPTION			
$\oplus$	ELEVATION HEIGHT/ LEVEL			
I SIM	SECTION/ DETAIL REFERENCE DRAWING NUMBER/ SHEET NUMBER			
101	DOOR NUMBER			
1 Ref 22 1 A101 1 1 Ref	INTERIOR ELEVATION REFERENCE			
Ref	EXTERIOR ELEVATION REFERENCE			
$\bigcirc$	NORTH ARROW			
N 90 00' 00" E Distance	PROPERTY LINE COORDINATES/ LENGTH			
<b>Room name</b> 101	ROOM NAME AND NUMBER			
1 A101 SIM	SECTION REFERENCE			
(1t)	WINDOW SYMBOL			

SYMBOLS

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St.TREI

110Frank

# SHEET INDEX

- A1 Site Plan
- A2 Floor Plan A3 Elevations
- A4 Framing Plan
- A5 Electrical Plan

# AREA EVALUATION

Living Area	1,132 S.F.		
TOTAL LIVING AREA	1,132 S.F.		
Rear Porch	102 S.F.		
Storage	48 S.F.		
Front Porch	87 S.F.		
TOTAL UNCONDITIONED AREA	237 S.F.		
TOTAL AREA UNDER ROOF	1,369 S.F.		
Note: Totals are sums of unrounded individual areas.			



Date Issued
December 11, 2023
Reviewed By
BPS

Scale as Drawn

Sheet Title

Sheet No.

Drawn By

Scale


Site Plan

20-024b

EPB, RJD

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ess	Operation	Description	Location
4"	Swing Simple	Steel frame door with Vision lite, weatherstripping, and threshold	Living
4"	Swing Simple	Steel frame door with Vision lite, weatherstripping, and threshold	Kitchen
4"	Swing Simple	Steel frame door with weatherstripping, and threshold	Ext. Storage
4"	Swing Simple	4-panel, molded hardboard, raised panel door	Laundry
4"	Swing Simple	4-panel, molded hardboard, raised panel door	Bath 2
4"	Swing Simple	4-panel, molded hardboard, raised panel door	Closet 2
4"	Swing Simple	4-panel, molded hardboard, raised panel door	Bedroom 3
4"	Swing Simple	4-panel, molded hardboard, raised panel door	Mech
4"	Swing Simple	4-panel, molded hardboard, raised panel door	Bath Closet
4"	Swing Simple	4-panel, molded hardboard, raised panel door	Bath
4"	Swing Simple	4-panel, molded hardboard, raised panel door	Bedroom 2
4"	Swing Simple	4-panel, molded hardboard, raised panel door	Closet 2
4"	Swing Simple	4-panel, molded hardboard, raised panel door	Bedroom 1
4"	Swing Simple	4-panel, molded hardboard, raised panel door	Closet 1

### 1. Refer to Building Elevations for all door light muntin patterns and panel configurations.

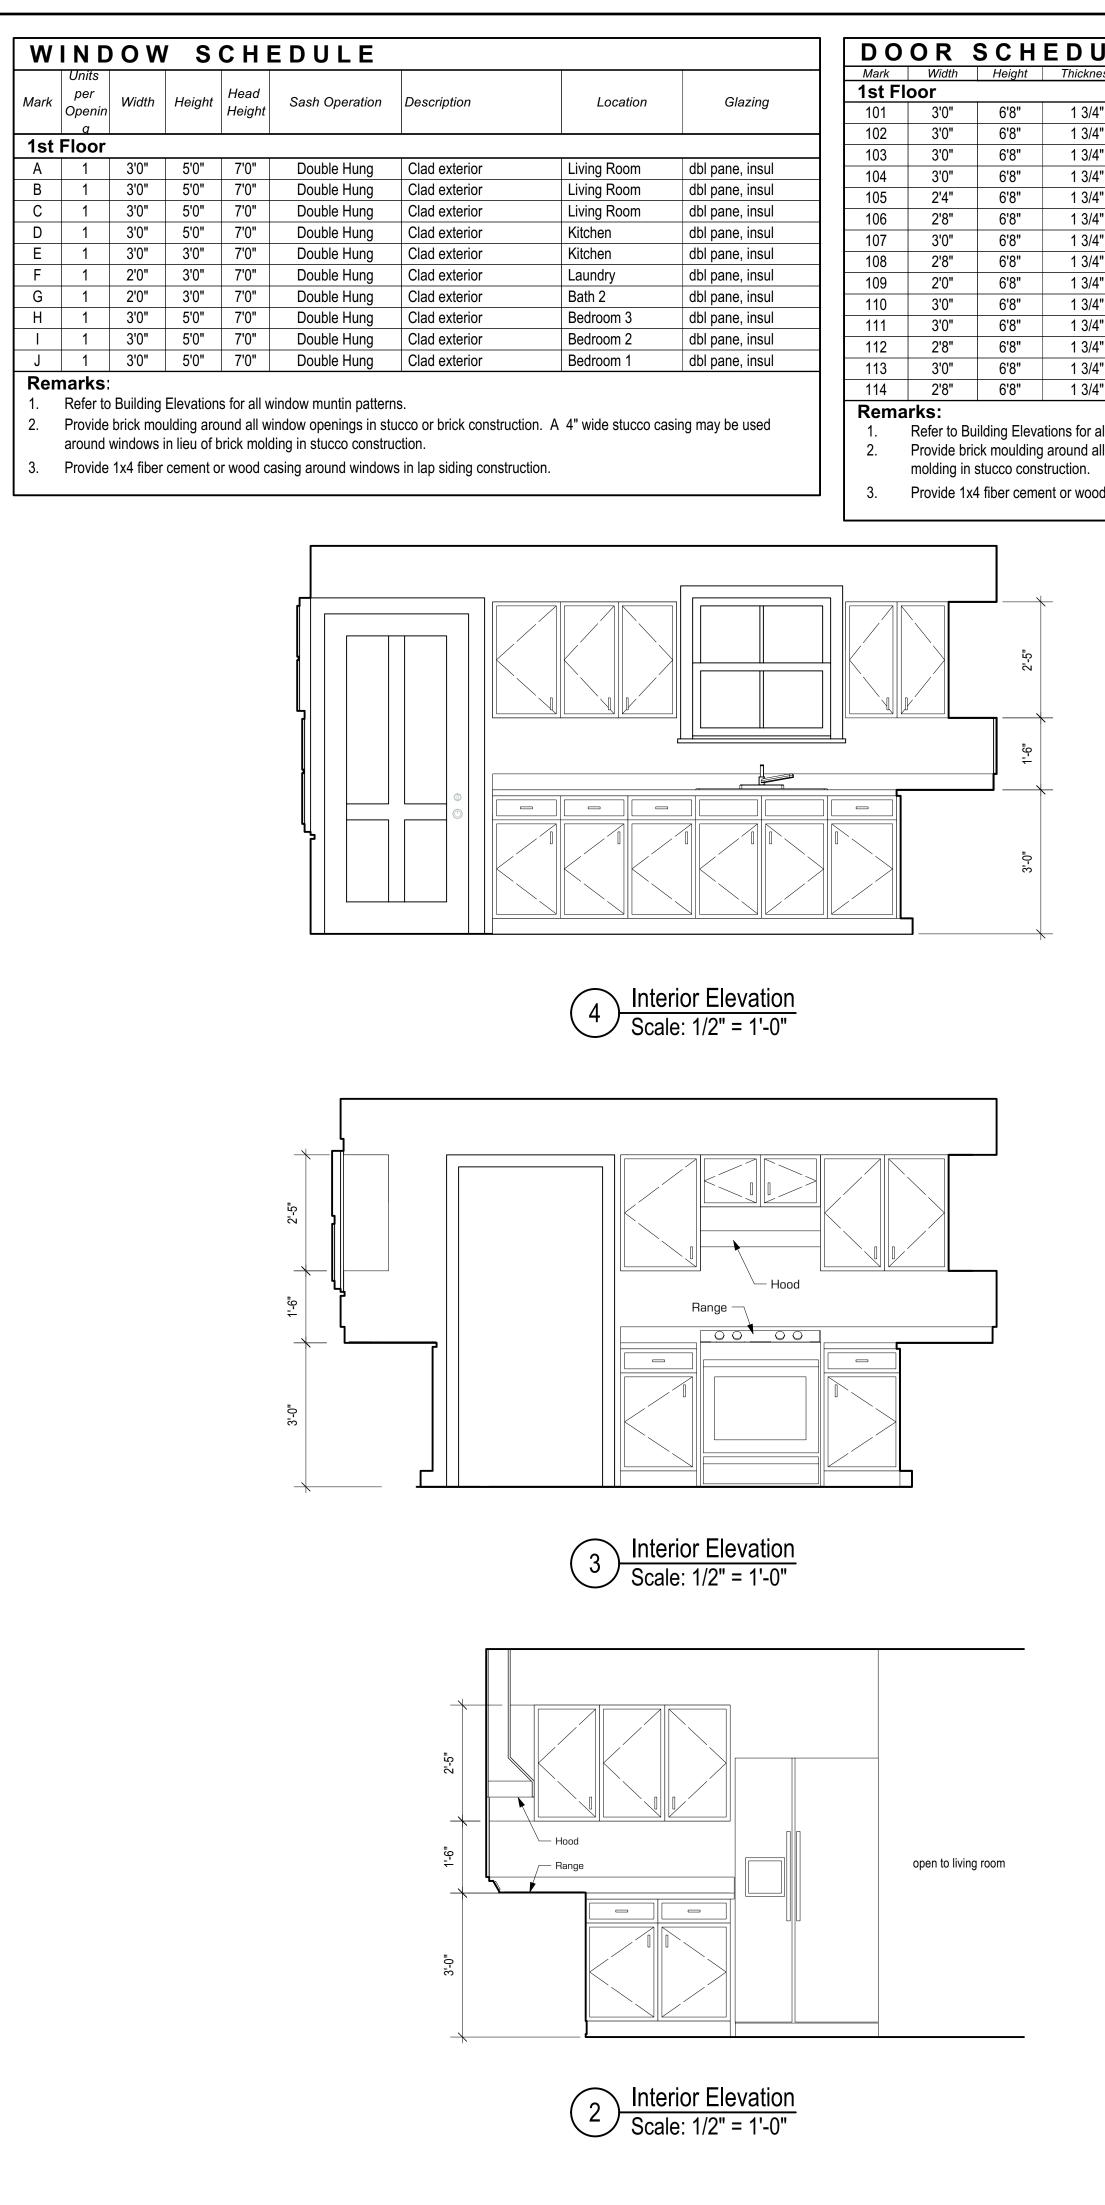2. Provide brick moulding around all door openings in stucco or brick construction. A 4" wide stucco casing may be used around doors in lieu of brick

3. Provide 1x4 fiber cement or wood casing around doors in lap siding construction.


1st Floor In	terior Rooms							
Room Name	Floor	Floor Area	Base	Wall	Casing	Ceiling	Crown	Ceiling Hgt Remark
Bath		58 sq ft	3 1/4"	1/2" gyp. bd.	2 1/4"	1/2" gyp. bd.		8'0"
Bath 2		46 sq ft	3 1/4"	1/2" gyp. bd.	2 1/4"	1/2" gyp. bd.		8'0"
Bedroom 1		116 sq ft	3 1/4"	1/2" gyp. bd.	2 1/4"	1/2" gyp. bd.		8'0"
Bedroom 2		112 sq ft	3 1/4"	1/2" gyp. bd.	2 1/4"	1/2" gyp. bd.		8'0"
Bedroom 3		142 sq ft	3 1/4"	1/2" gyp. bd.	2 1/4"	1/2" gyp. bd.		8'0"
Closet		4 sq ft	3 1/4"	1/2" gyp. bd.	2 1/4"	1/2" gyp. bd.		8'0"
Closet 1		8 sq ft	3 1/4"	1/2" gyp. bd.	2 1/4"	1/2" gyp. bd.		8'0"
Closet 2		14 sq ft	3 1/4"	1/2" gyp. bd.	2 1/4"	1/2" gyp. bd.		8'0"
Closet 2		16 sq ft	3 1/4"	1/2" gyp. bd.	2 1/4"	1/2" gyp. bd.		8'0"
Kitchen		201 sq ft	3 1/4"	1/2" gyp. bd.	2 1/4"	1/2" gyp. bd.		8'0"
Laundry		27 sq ft	3 1/4"	1/2" gyp. bd.	2 1/4"	1/2" gyp. bd.		8'0"
Living Room		223 sq ft	3 1/4"	1/2" gyp. bd.	2 1/4"	1/2" gyp. bd.		8'0"
Mech		8 sq ft	3 1/4"	1/2" gyp. bd.	2 1/4"	1/2" gyp. bd.		8'0"
Pantry		25 sq ft	3 1/4"	1/2" gyp. bd.	2 1/4"	1/2" gyp. bd.		8'0"
1st Floor Ex	terior Spaces	, ;			·			
Room Name	Floor	Floor Area	Base	Wall	Casing	Ceiling	Crown	Ceiling Hgt Remark
Storage		42 sq ft	N/A	Type X 5/8" gyp. bd.	N/A	Type X 5/8" gyp. bd.		8'0"
Rear Porch		102 sq ft	N/A	See Elev.	See Elev.	Wood		8'0"
Front Porch		87 sq ft	N/A	See Elev.	See Elev.	Wood		8'0"


**MECHANICAL SYMBOLS** 

COLD WATER TAP


- GAS METER AND REGULATOR
- ୦୦୦ କୁଞ୍ଚି GAS SUPPLY VALVE
- •□ KEYED GAS VALVE

•• $\frac{m}{\pi}$  FROST FREE HOSE BIB

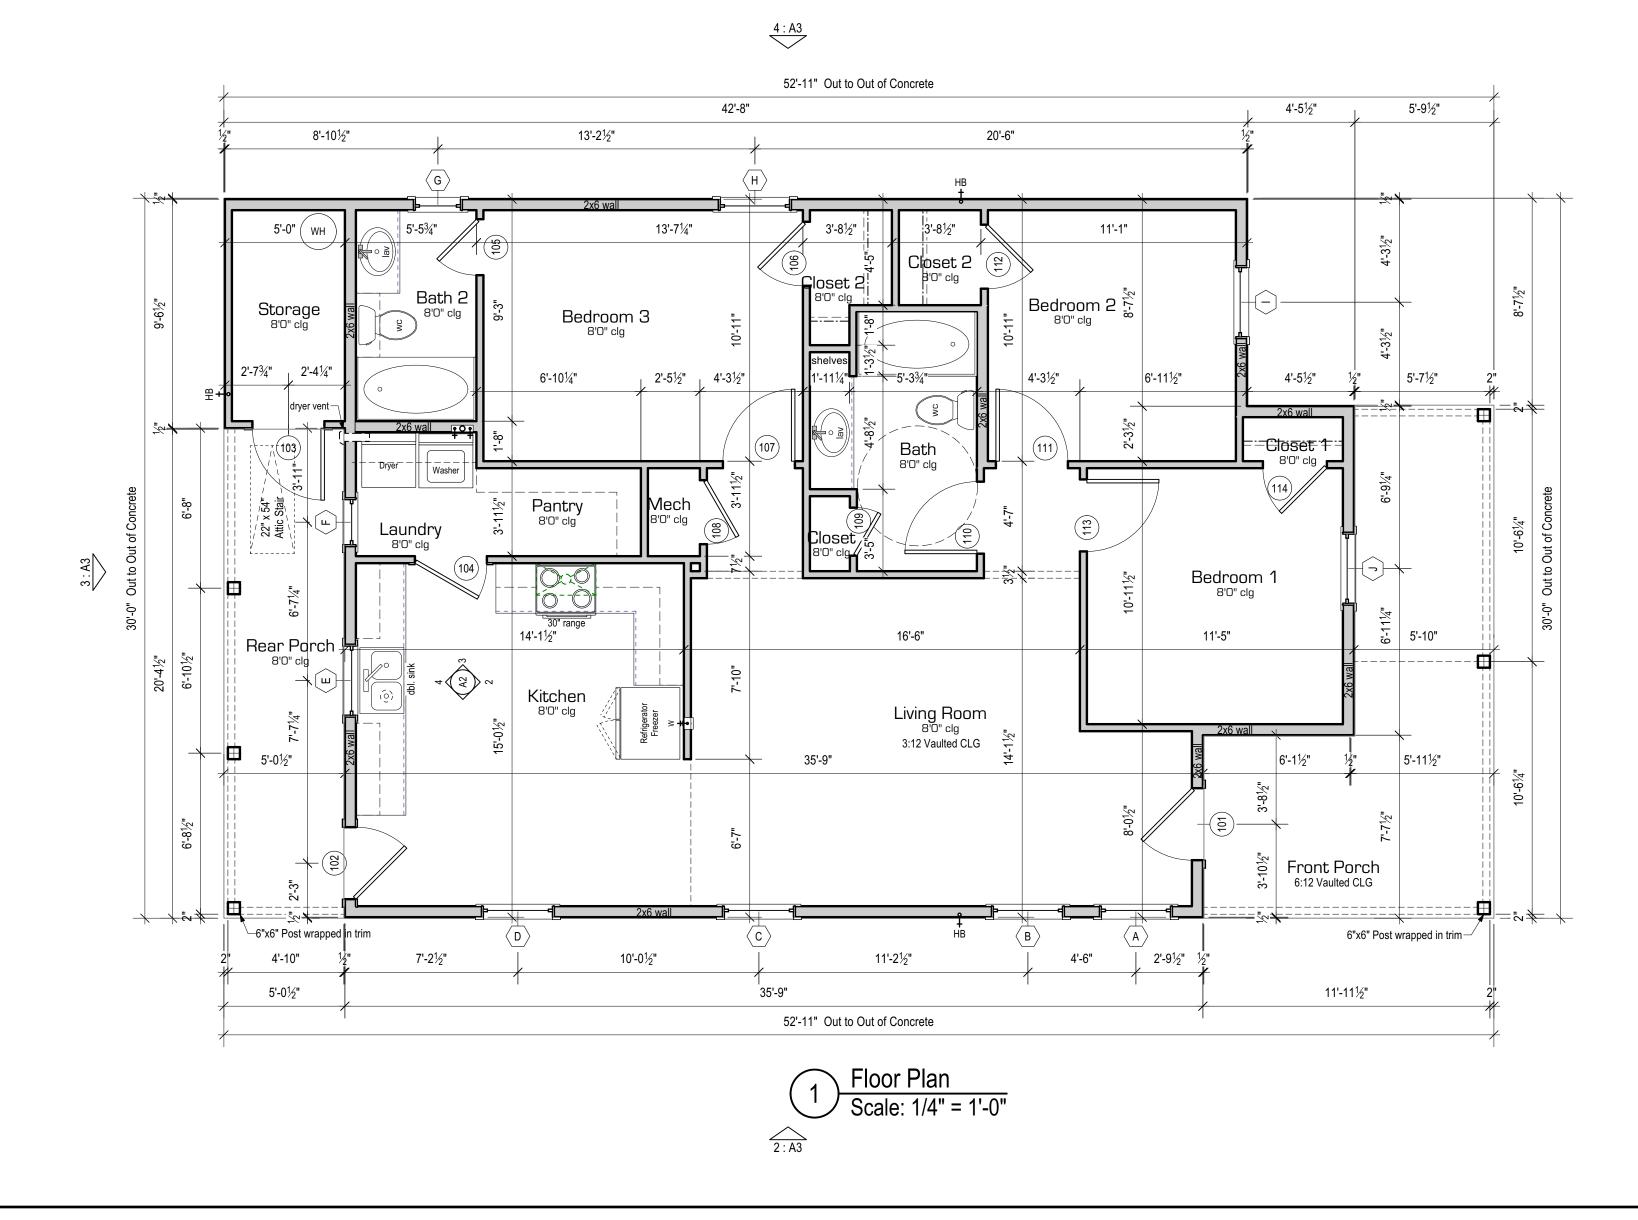

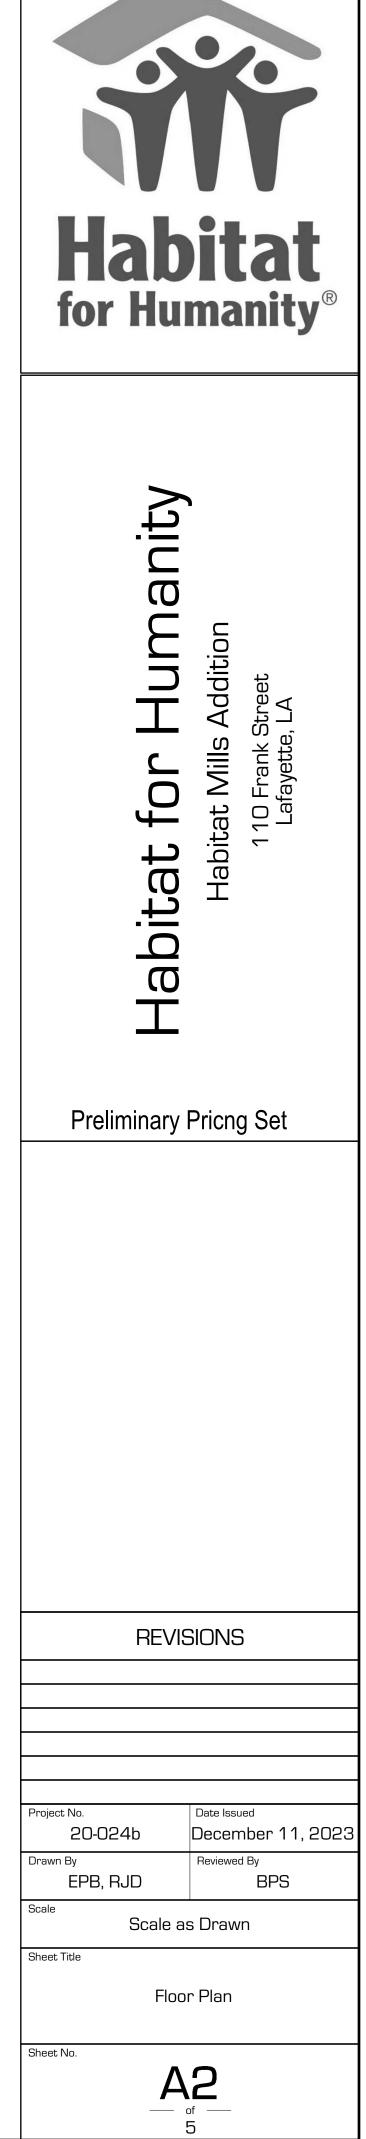



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For Reference Purposes Only (Not A Foundation Plan -

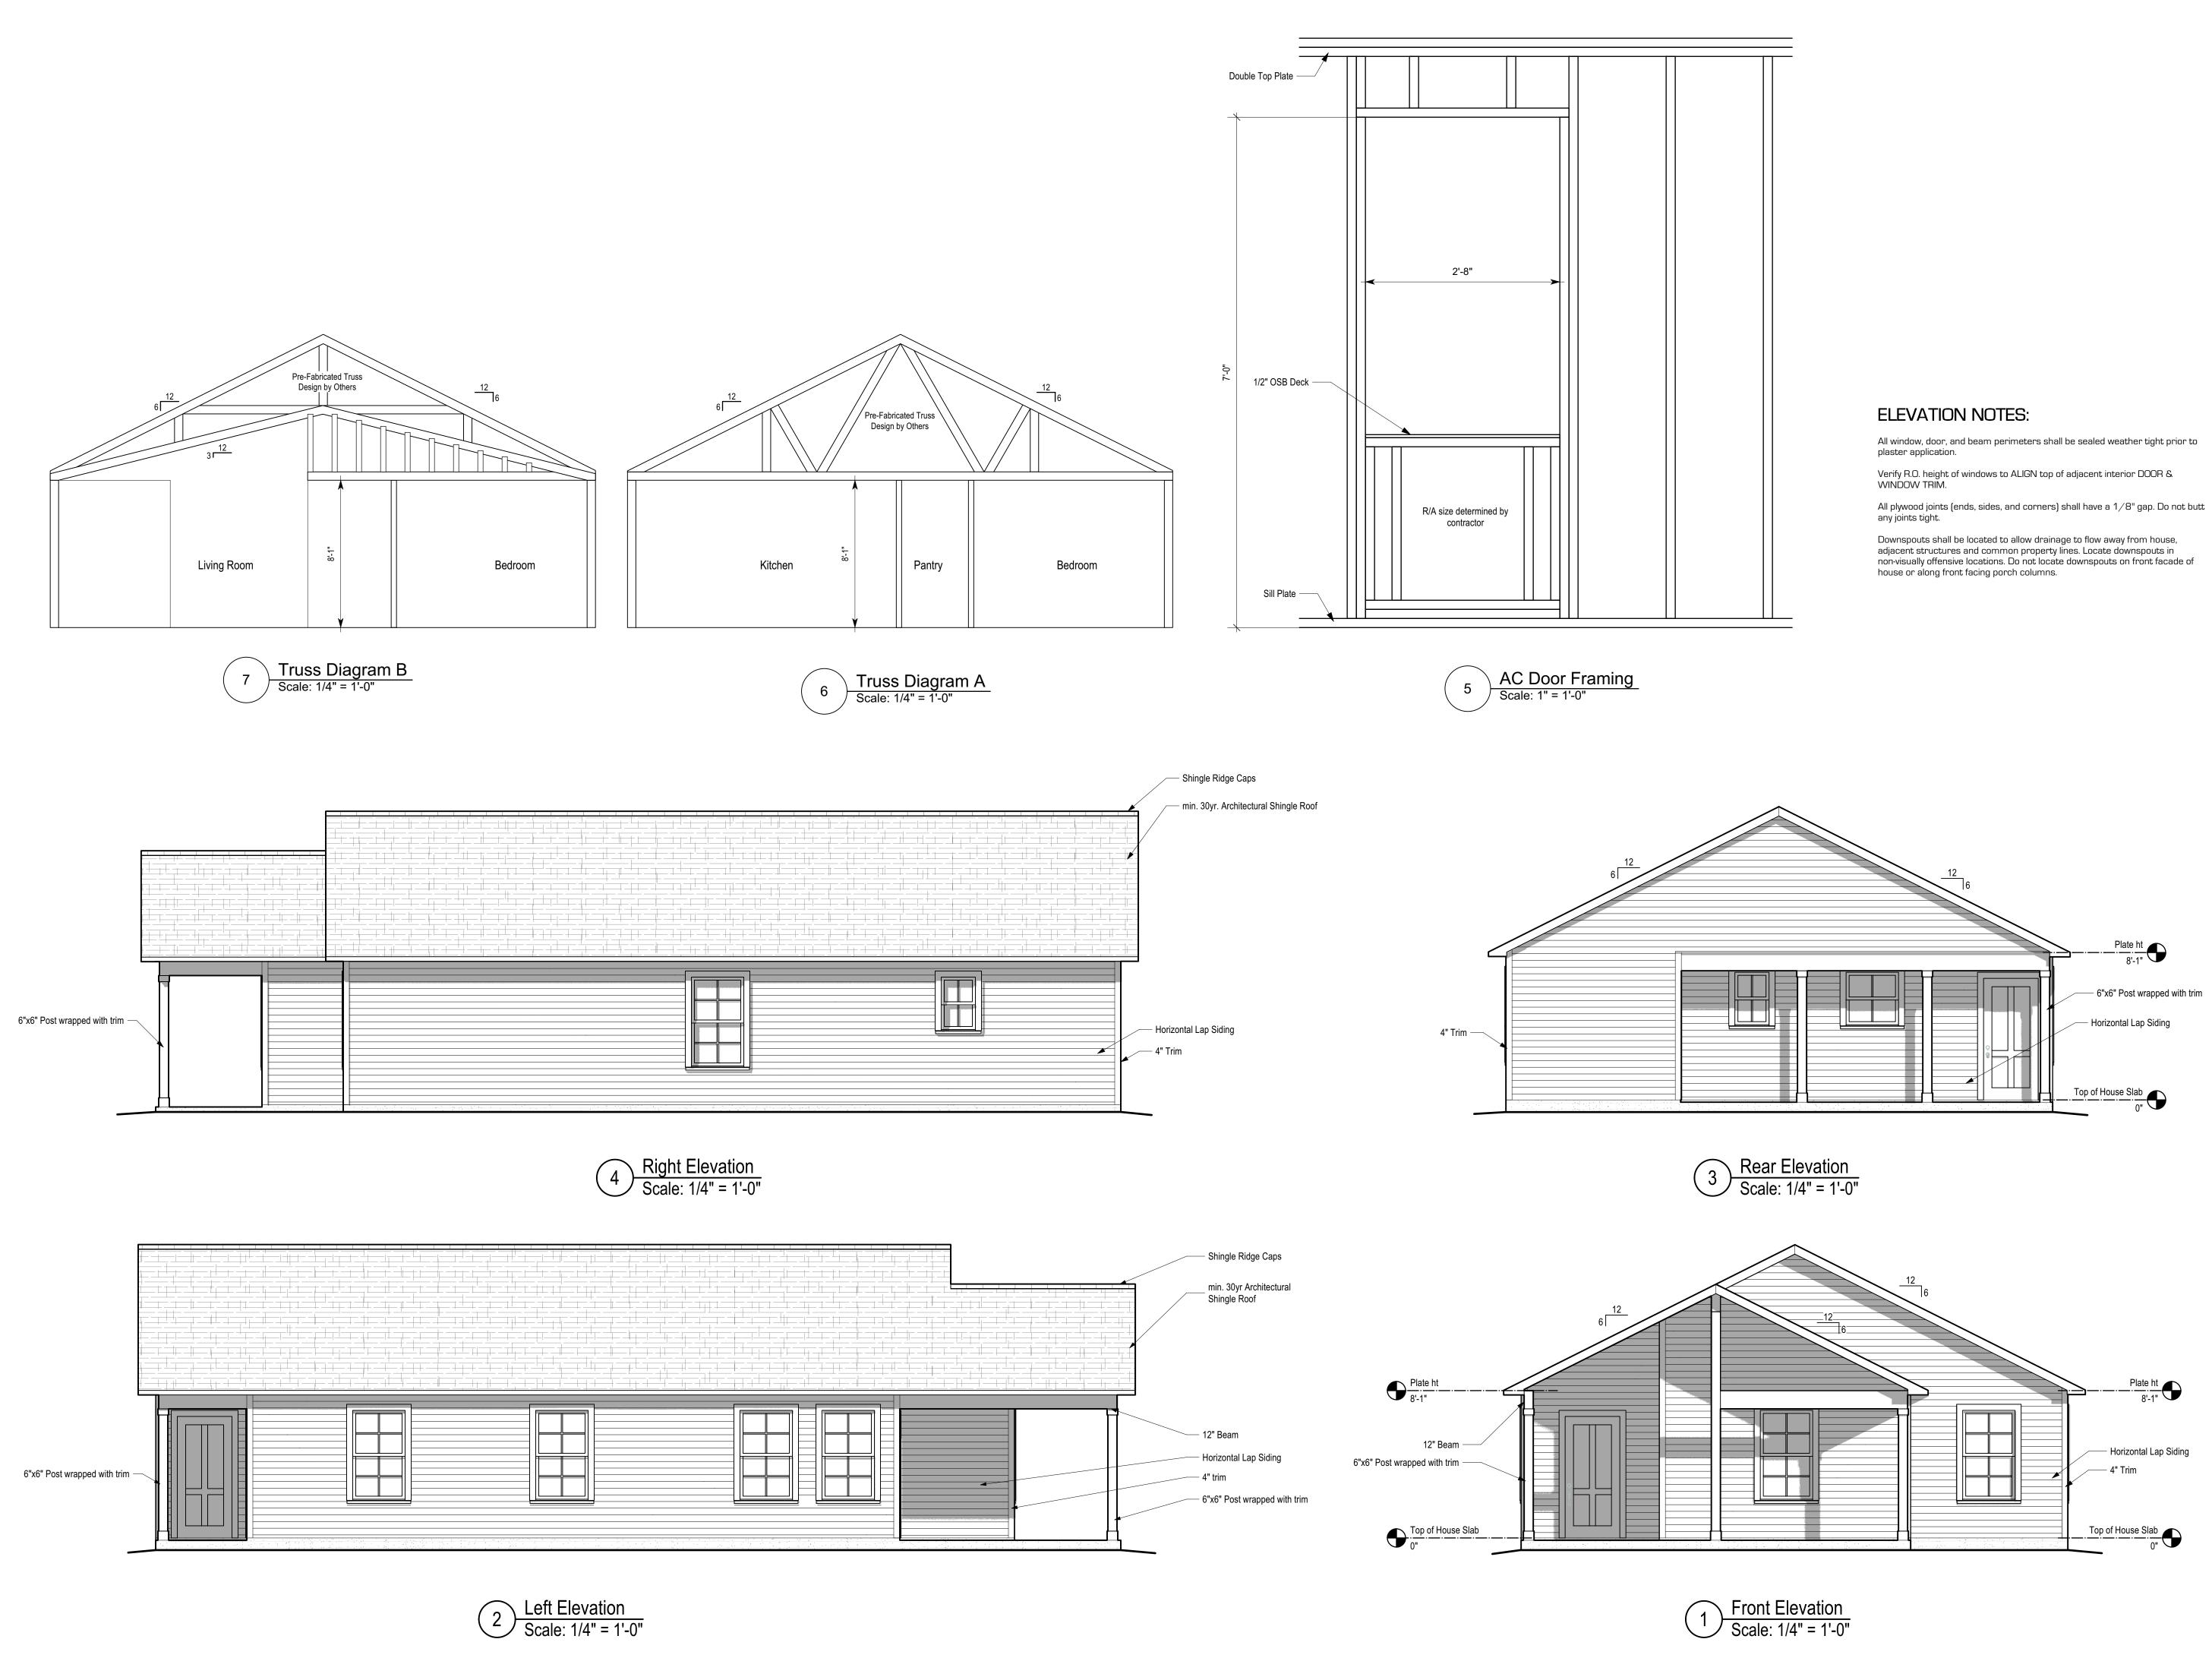2. Verify slab height of garage in relation to house slab height.

minimum of 2 bolts per plate section with 1 bolt located not more than 12" or less than 7 bolt diameters from each end.


1. All sole plates and sill plates on concrete shall have anchor bolts every 48" o.c. and shall be caulked generously

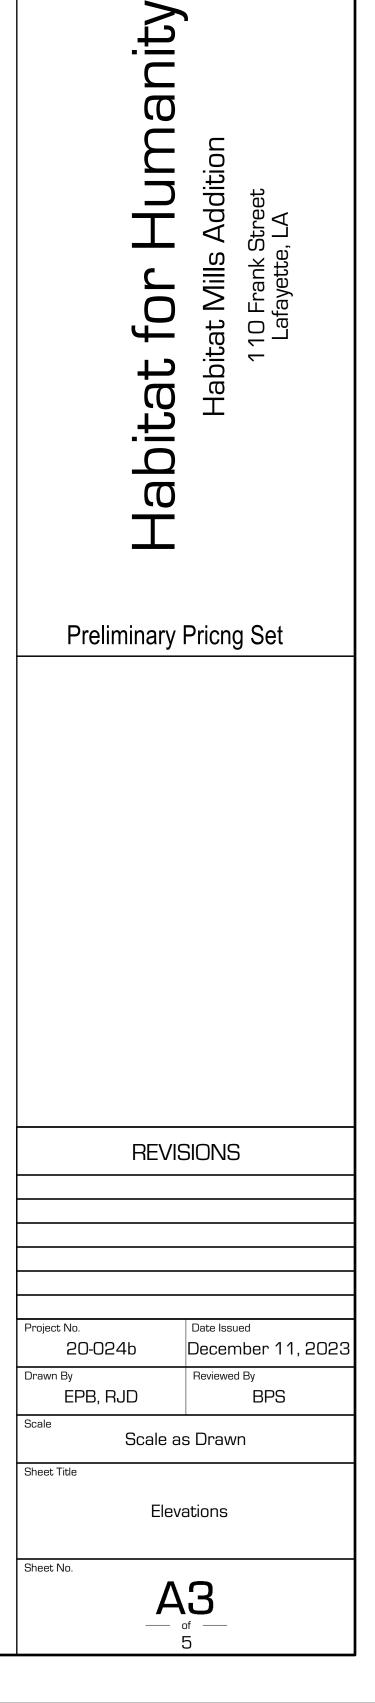2. Studs shall not be less than 2x4 or 2x6 at 16" on centers. use 2x6 or wider to conceal pipes where shown on plans. all

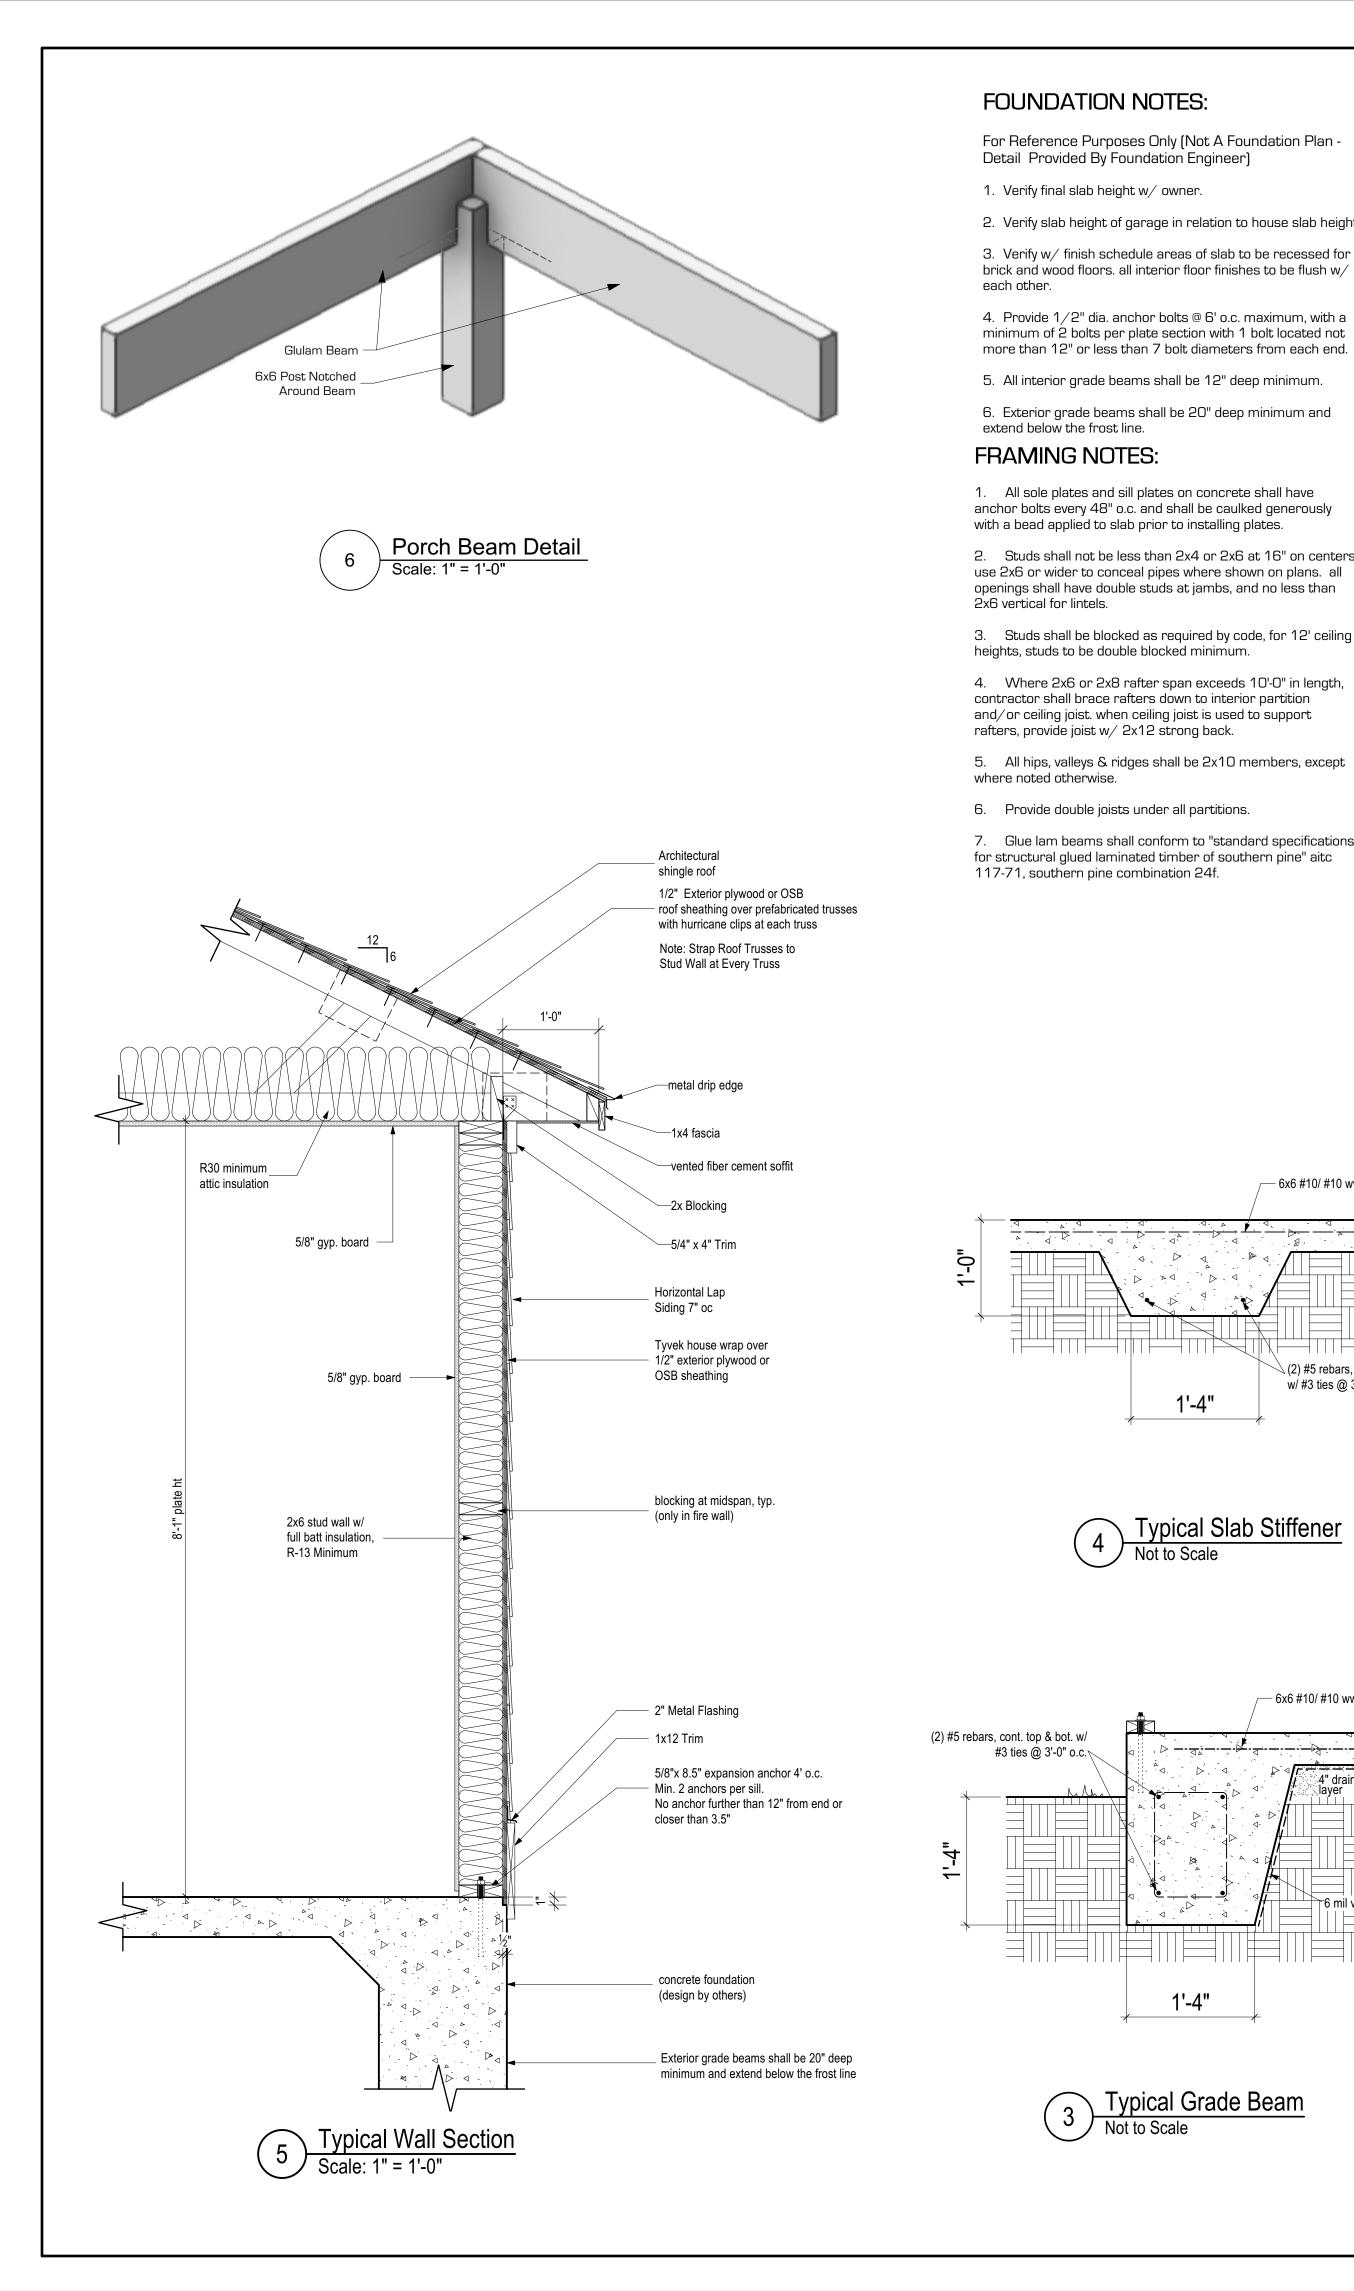
3. Studs shall be blocked as required by code, for 12' ceiling

4. Where 2x6 or 2x8 rafter span exceeds 10'-0" in length, contractor shall brace rafters down to interior partition


7. Glue lam beams shall conform to "standard specifications for structural glued laminated timber of southern pine" aitc

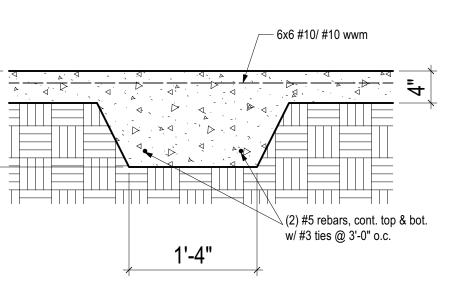



# Typical Slab Stiffener Not to Scale

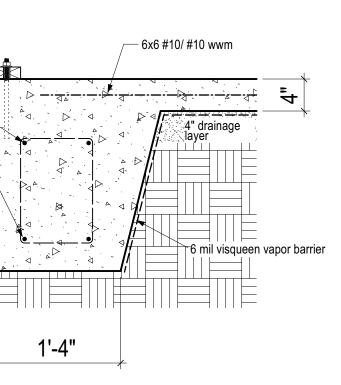


3 Typical Grade Beam Not to Scale

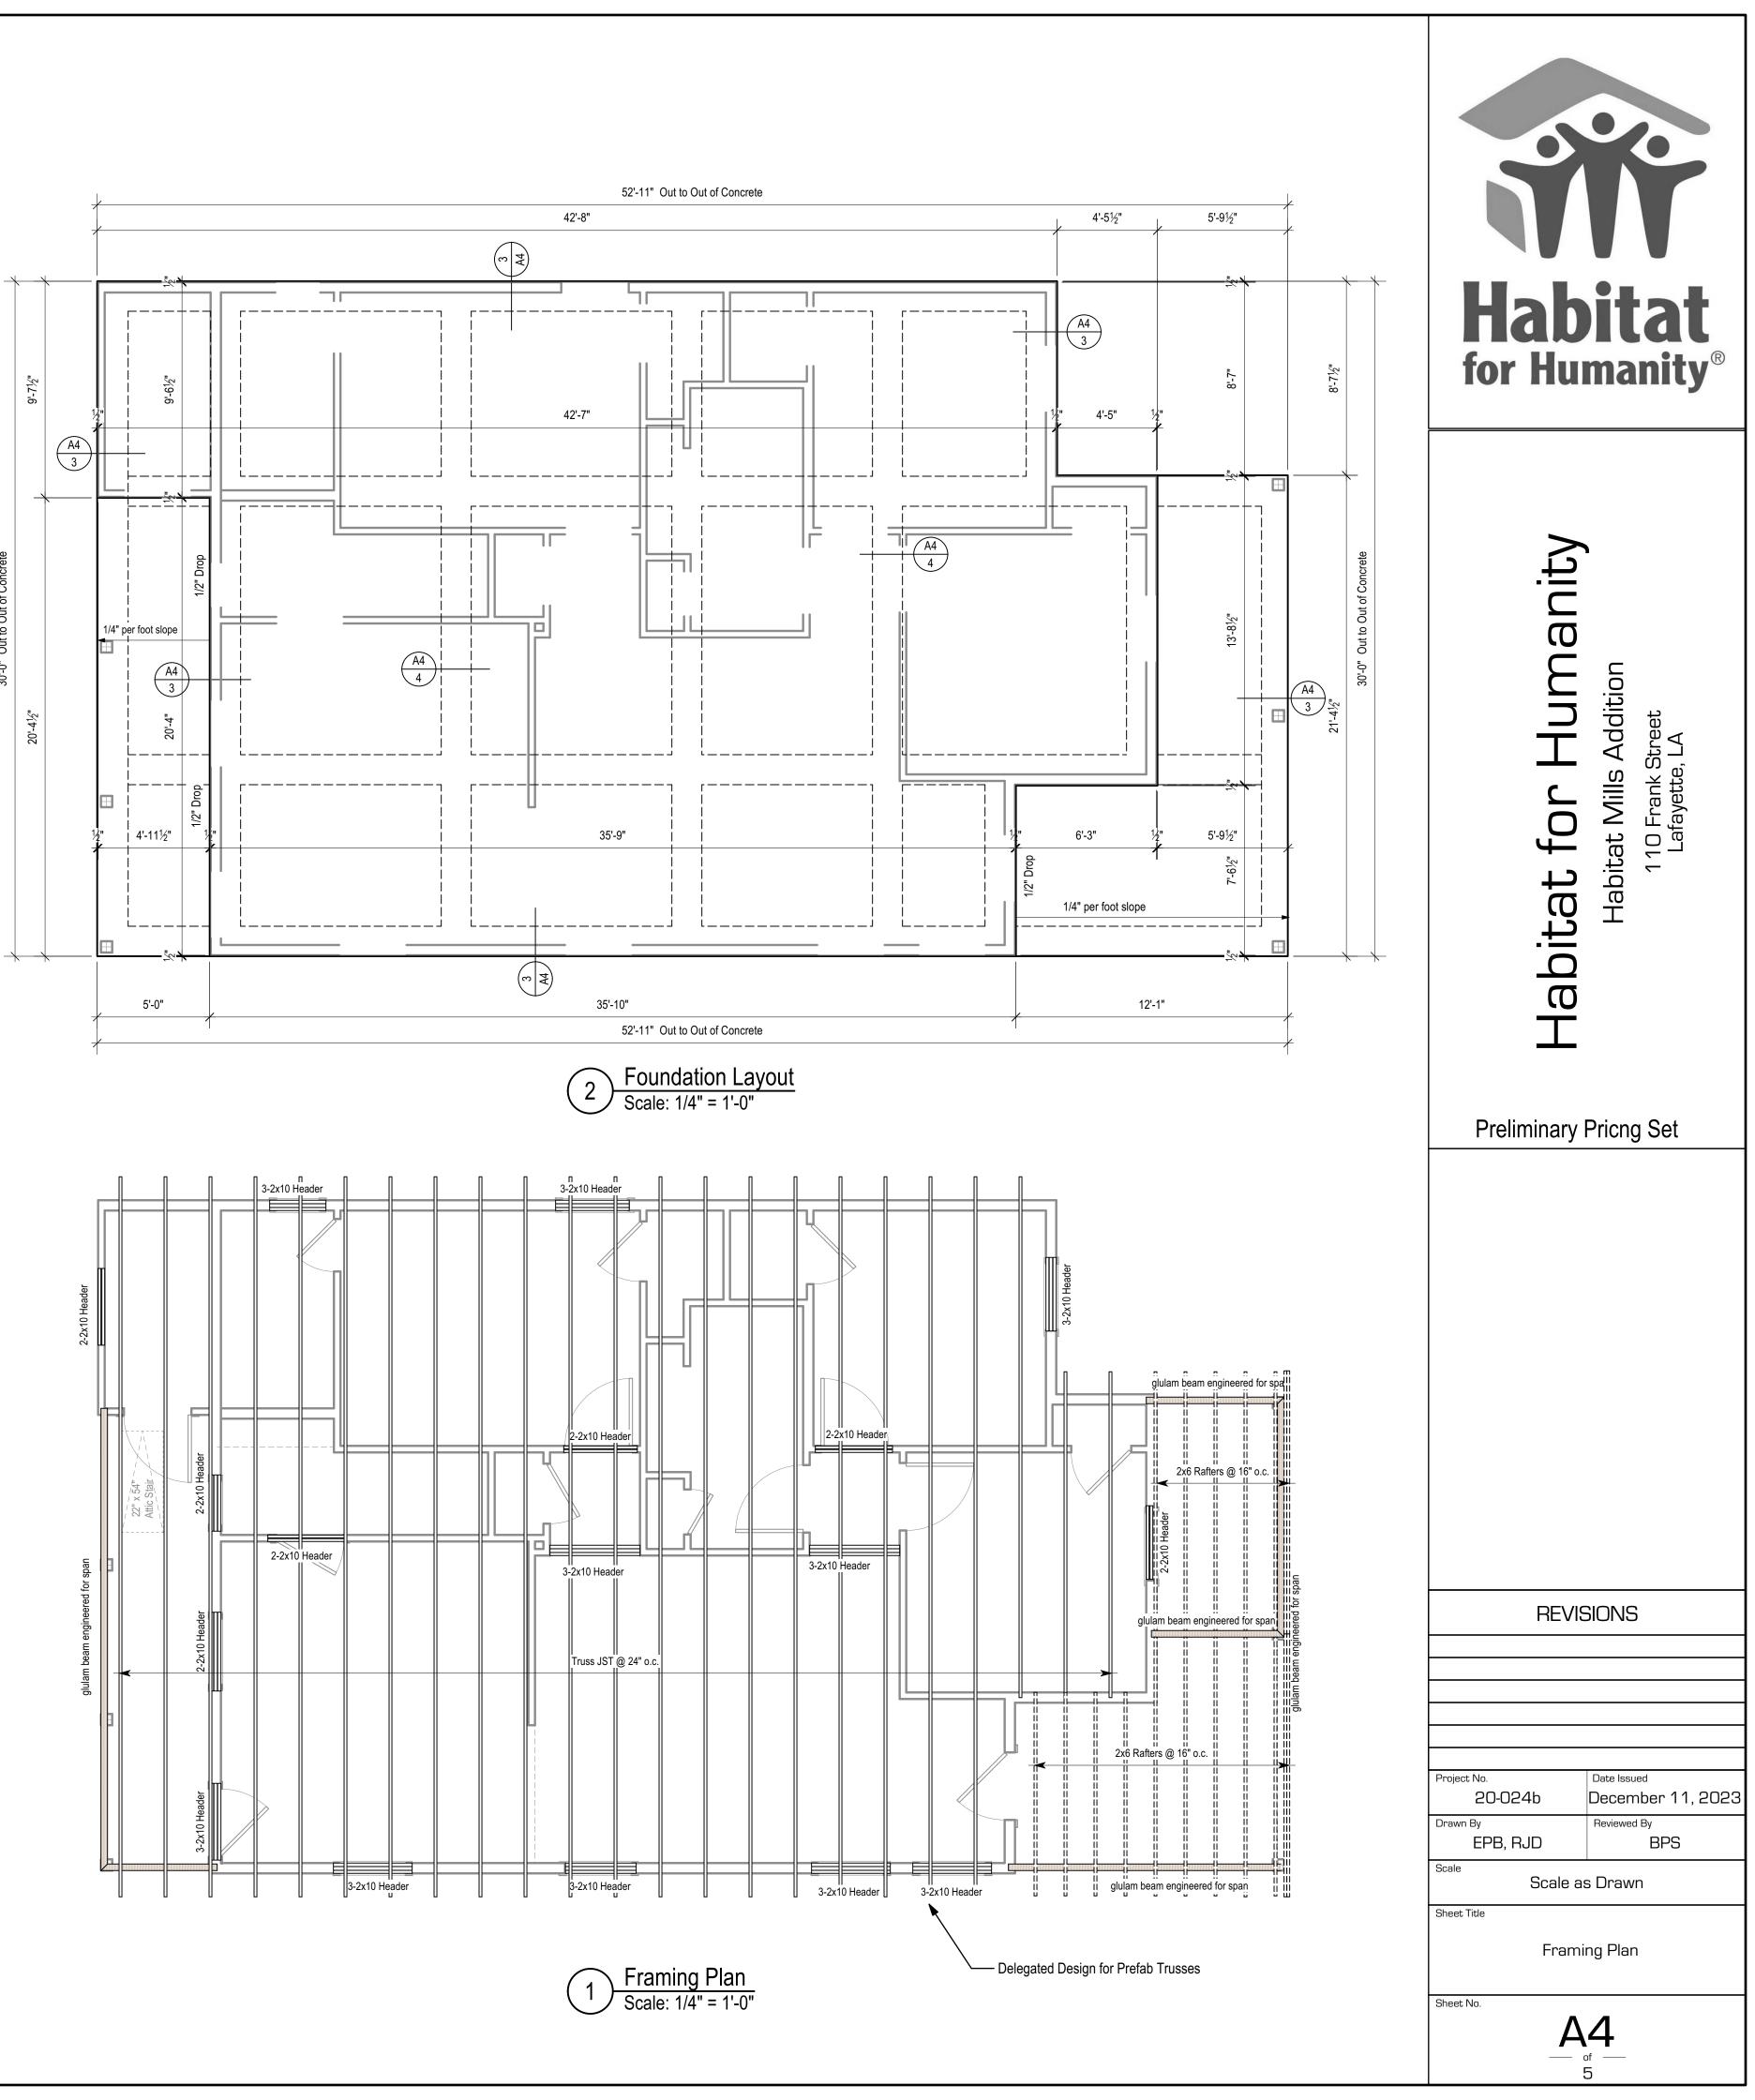

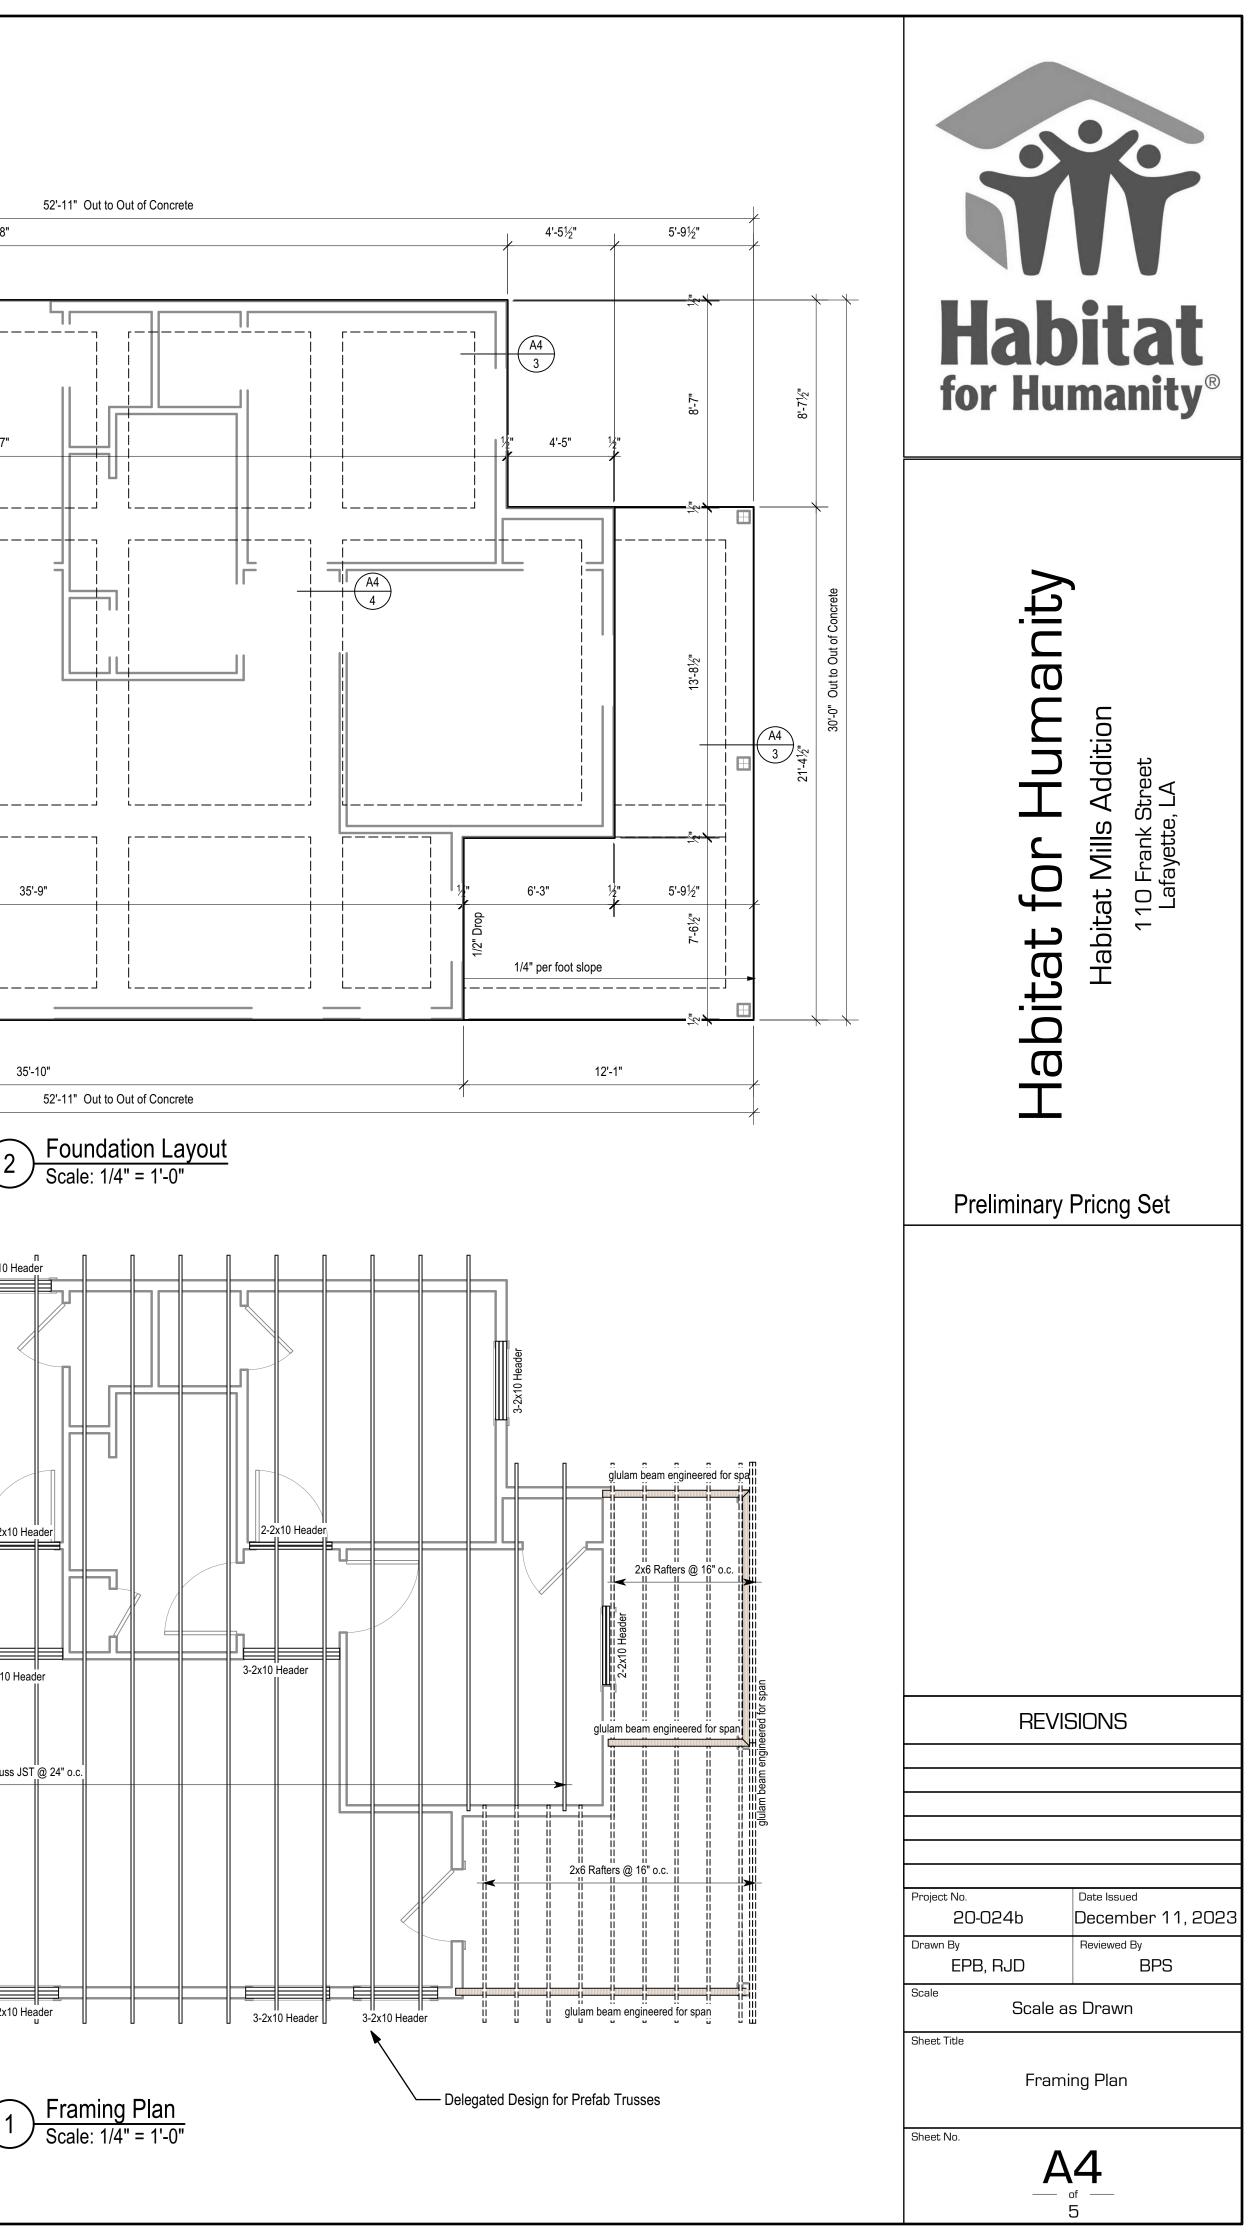

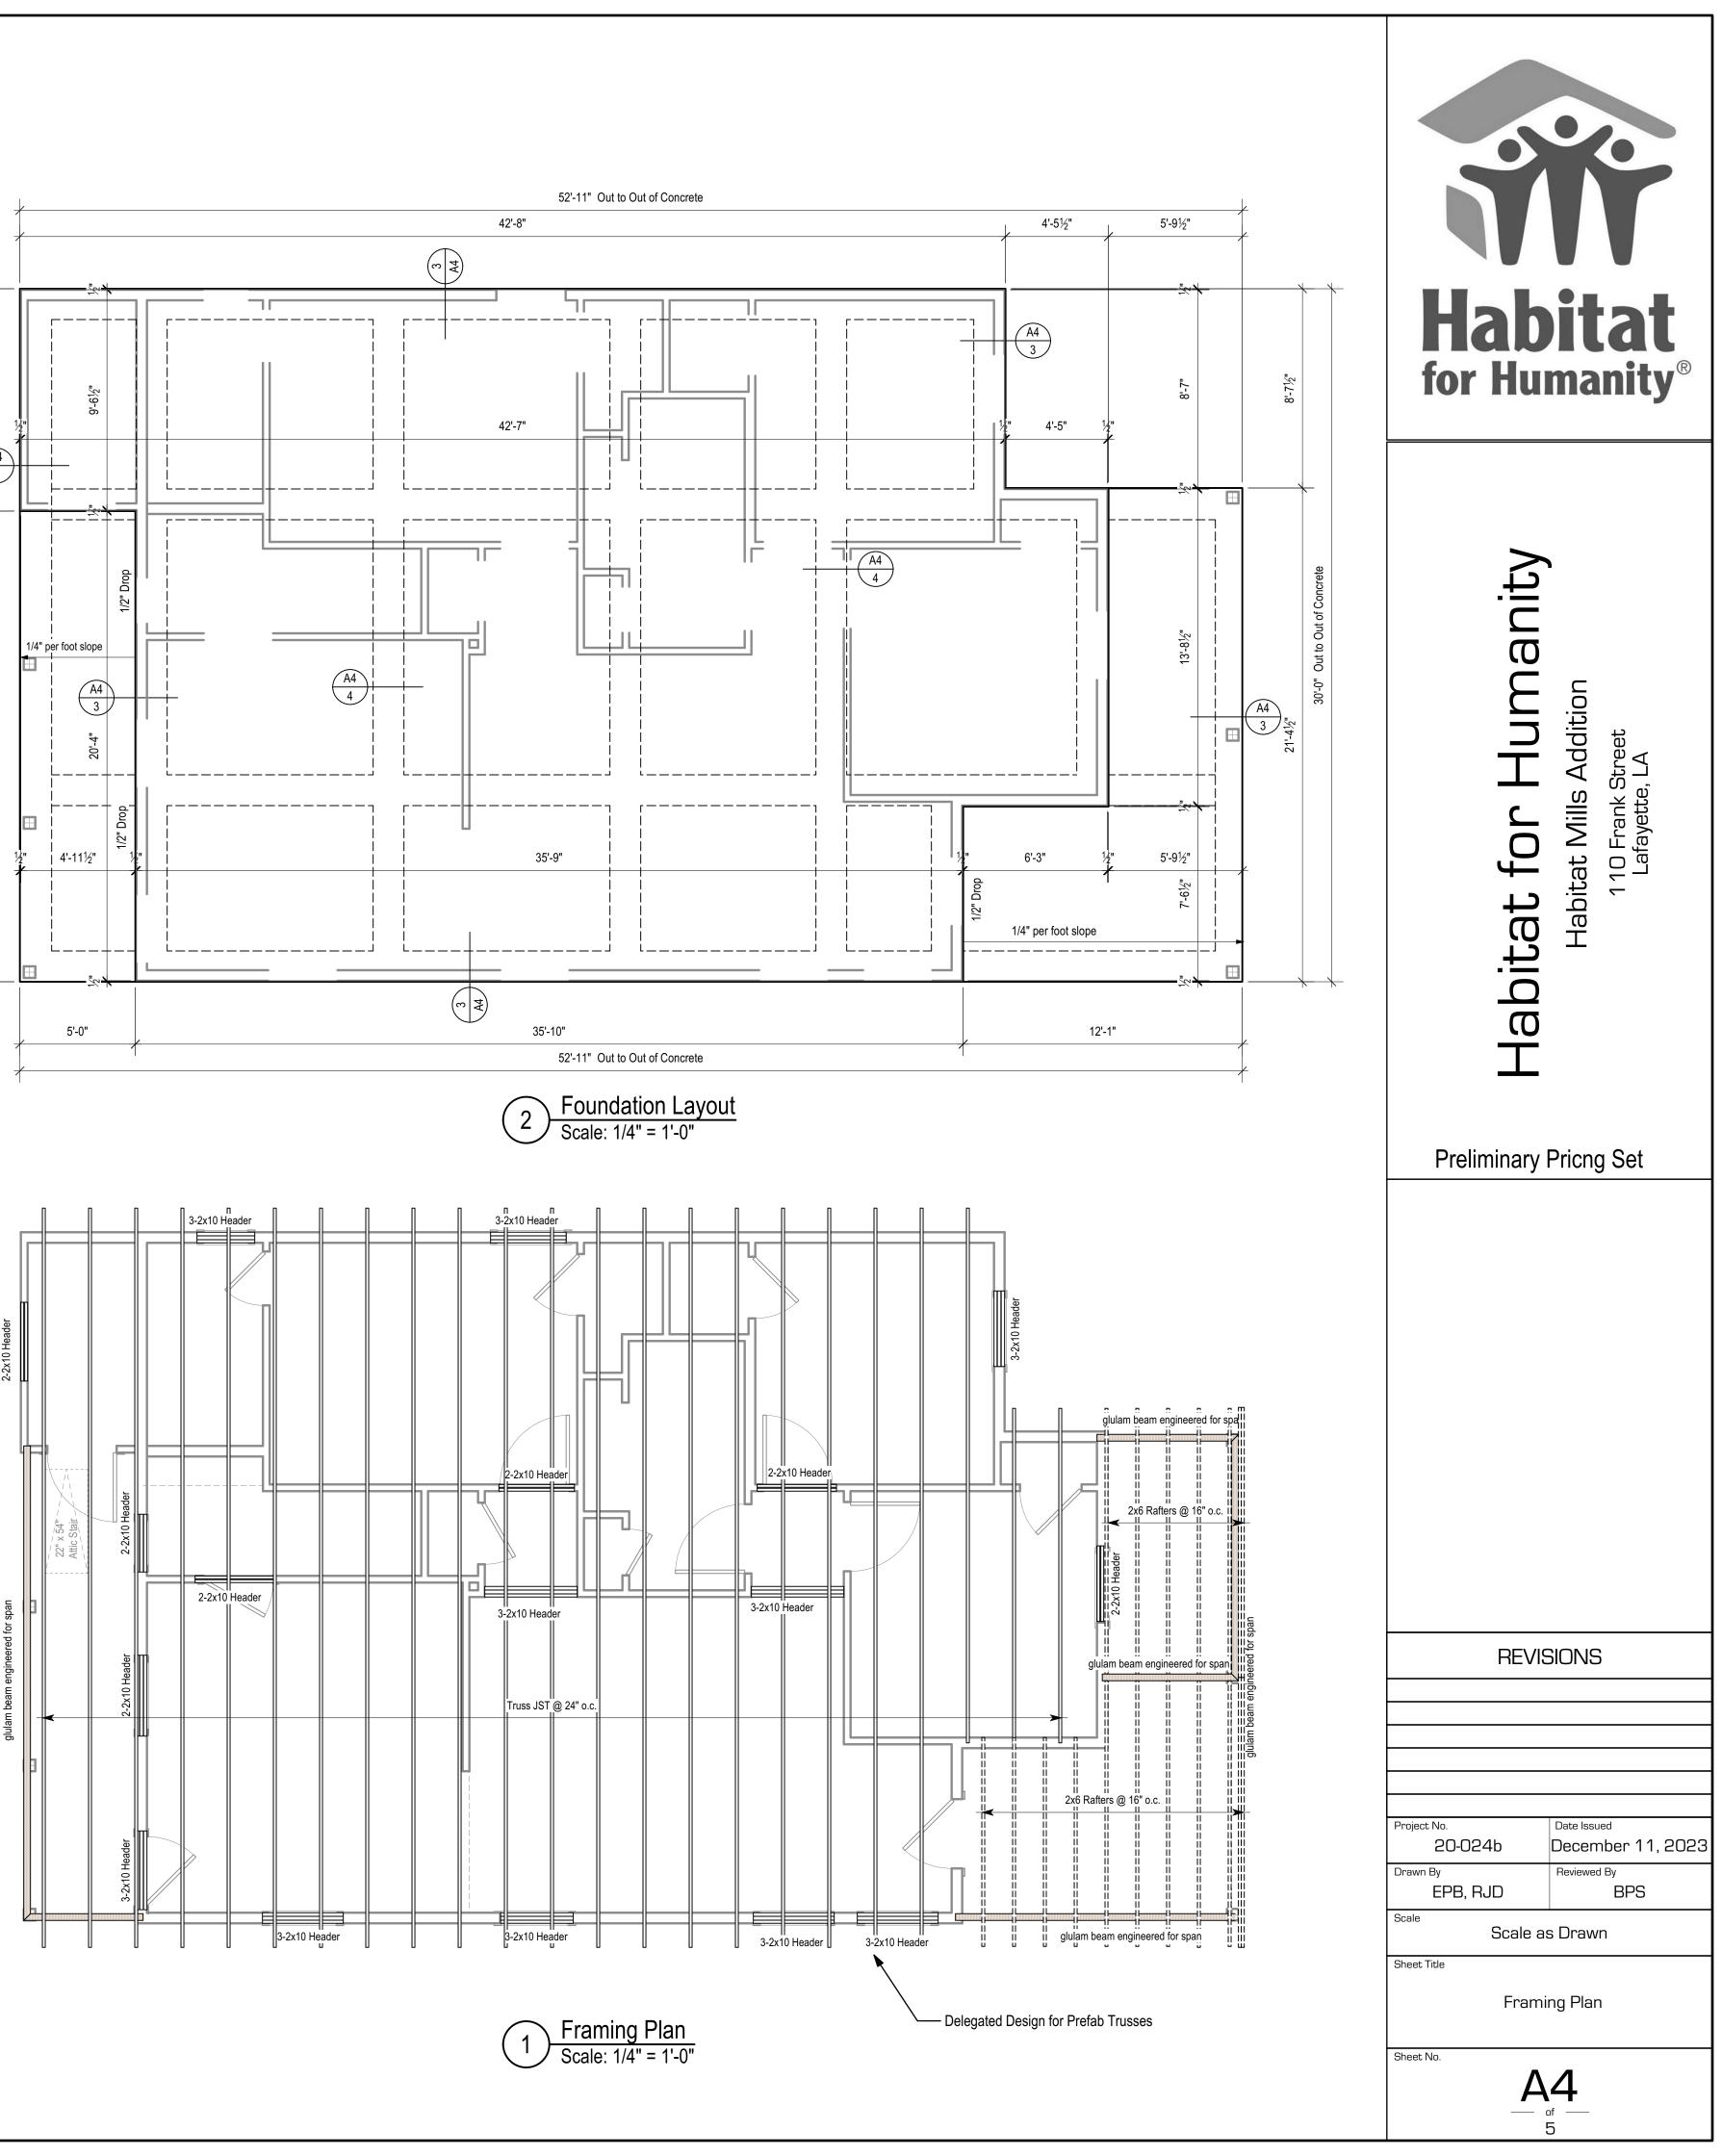



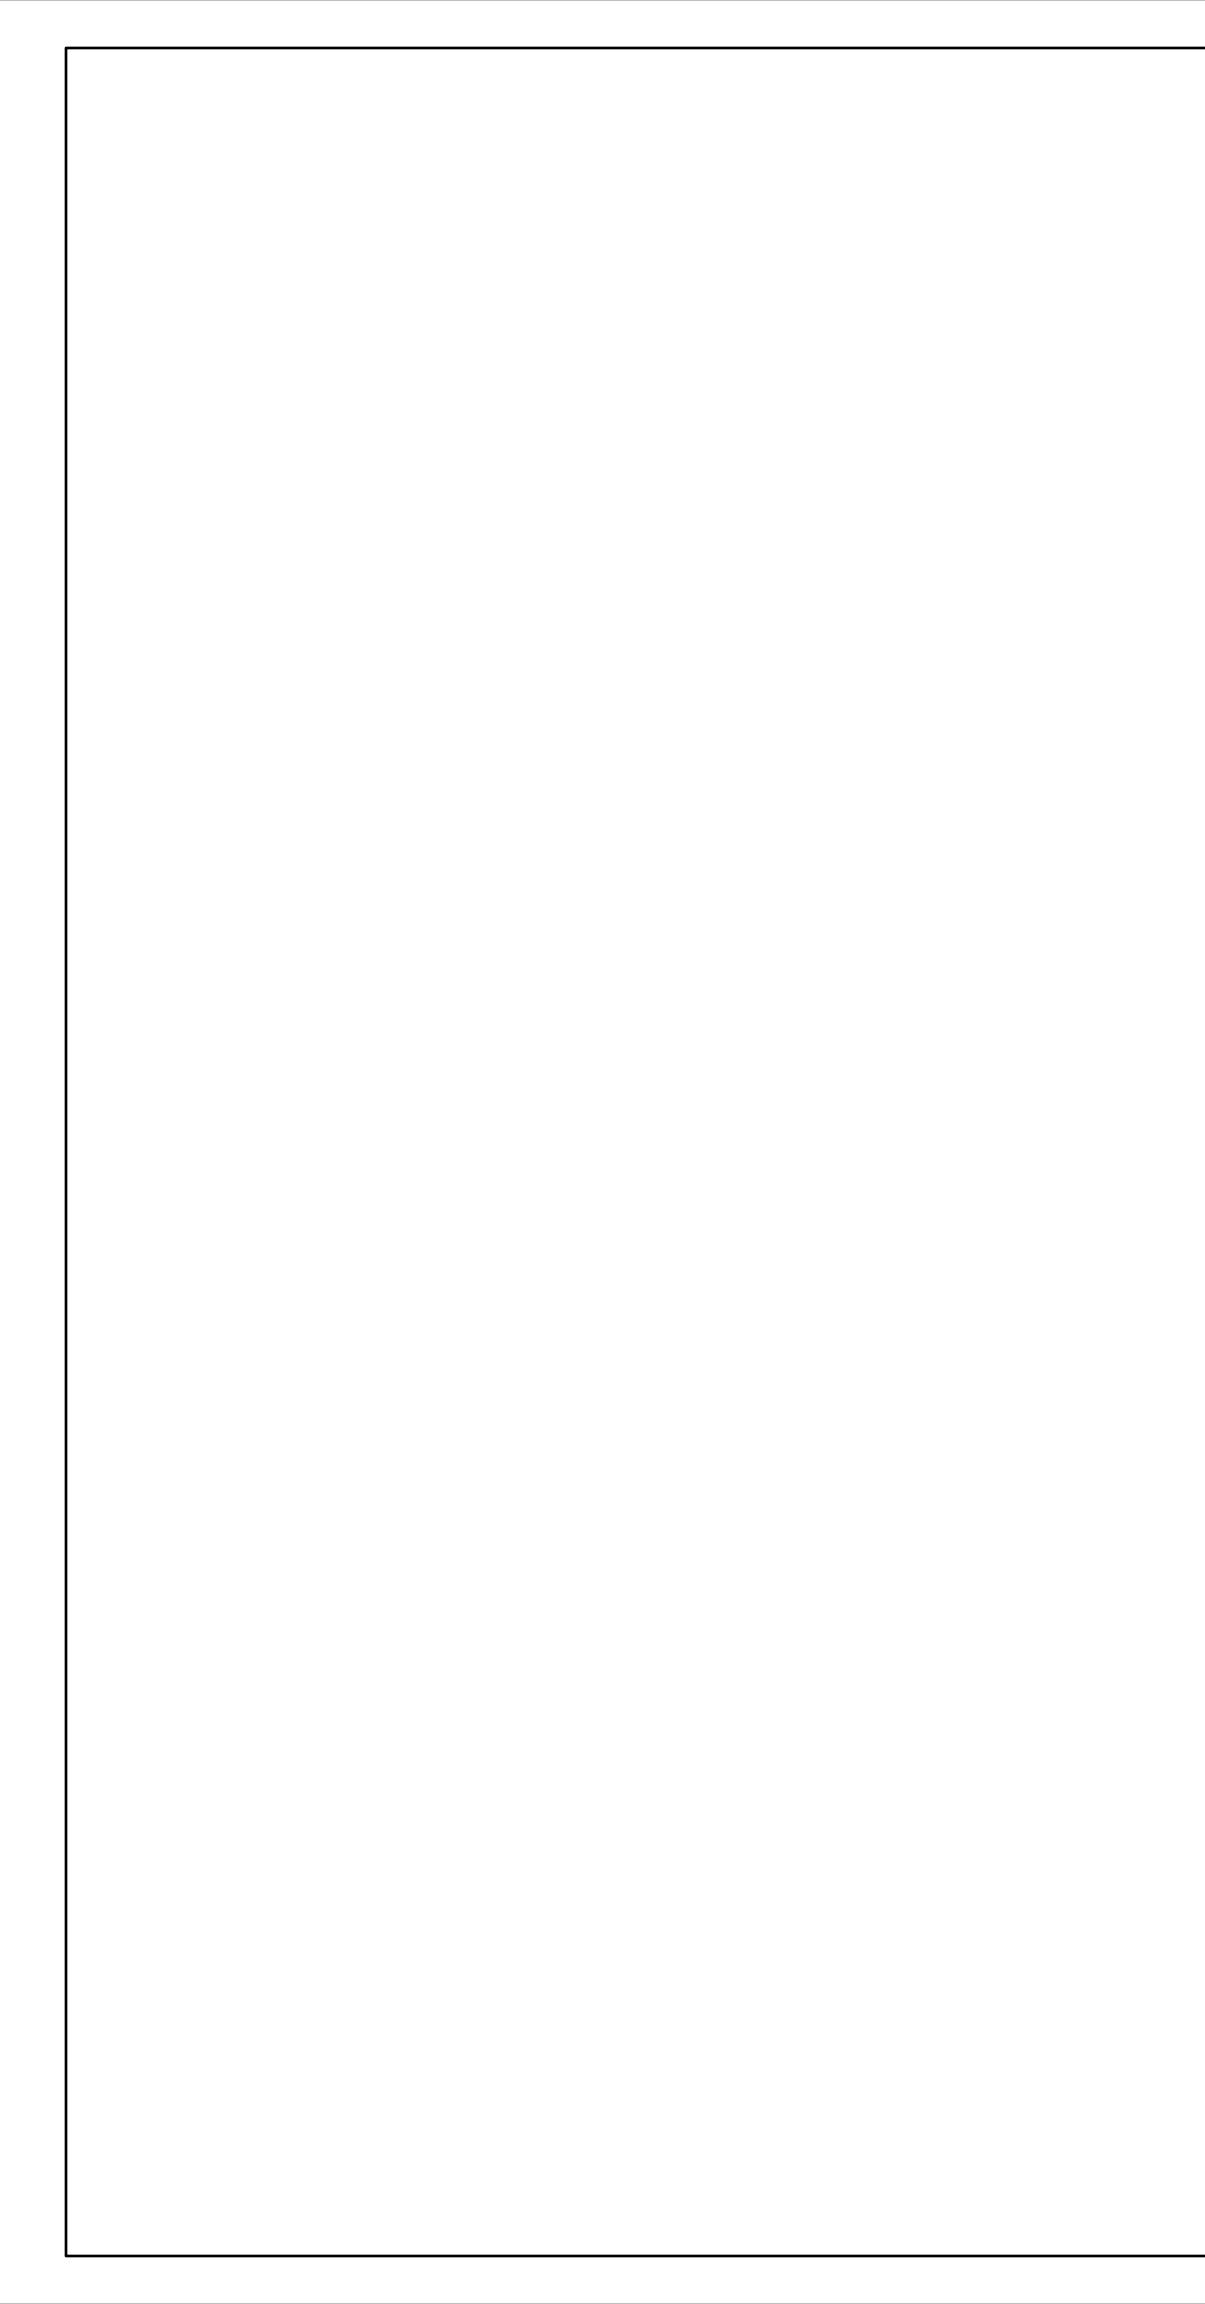

### ELECTRICAL NOTES:

1. All electrical installation shall be in accordance with the National Electrical Code, the Life Safety Code, all local and state codes, and the requirements and recommendations of the local power company.

2. All electrical equipment shall be connected in accordance with the instructions of the respective manufacturers.

3. All electrical equipment furnished shall be new and listed by U.L. for the exact application for which it is used.

4. All conductors shall be copper, and unless shown otherwise, utility company. the minimum size shall be #12 AWG. All conducters #8 AWG or larger shall be stranded.

5. Electrical cables shall be Romex. Electrical having or "THWN".

the service entrance and metering requirements approved in advance by the local power company. The meter centers furnished by the Contractor shall be approved in advance by the local power company.

permits and pay all legal fees and charges. He shall make inspector make periodic inspections as the electrical work progresses.

8. The system of wiring shall be 120/240, 10, 3W.

9. All ground rods shall be 3/4" diameter x 10'-0" long copperweld with bronze clamps for connection of grounding cables.

10. All materials, labor, equipment, and services required to the electrical plans to be "supplied by Owner", shall be furnished by the Contractor.

11. All temporary electrical service for construction power shall be furnished, installed and removed by the Contractor. He shall make arrangements with the power company, including arrangements for metering and billing. All connections and/or service charges for this service are considered part of the Contractor's contract and shall be paid by him. This service installation shall be in accordance with the National Electrical Code, all local codes, and all requirements and recommendations of the power company.

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	Pendant mount, LED
Ă	Wall mount, LED
$\bigcirc$	Recessed downlight, LED
$\bigcirc$	Recessed wall washer, adjust

